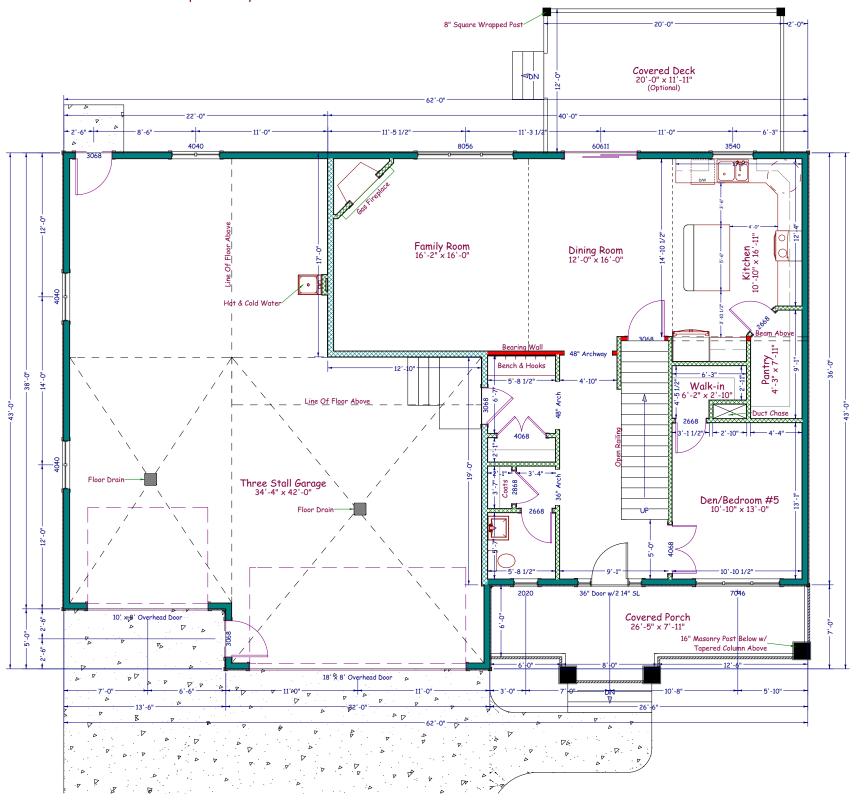
Main Floor:

All Exterior Dimensions Are From Outside Of Framing To Outside of Framing. All Interior Dimensions Are From Edge Of Framing To Edge Of Framing. Door Labels Are Specified By 3068 Which Translates To $3'-0" \times 6'-8"$. Window Labels Are Specified By 2040 Which Translates To $2'-0" \times 4'-0"$.



Main Floor Plan

Scale: 1/8"=1'-0"

*2x6 Exterior House Walls - 9'-1 1/8" High
*2x6 Exterior Garage Walls - 11'-2 1/4" High (Verify)
*8" Thick Concrete Basement Walls - 92 7/8" Ceiling
*20" Engineered Floor Trusses (Figured For Elevations)
Actual Truss Size May Differ (Verify w/Truss Company)

Square Foot Calculations:

Main Floor - 1197 SF

Second Floor - 1404 SF

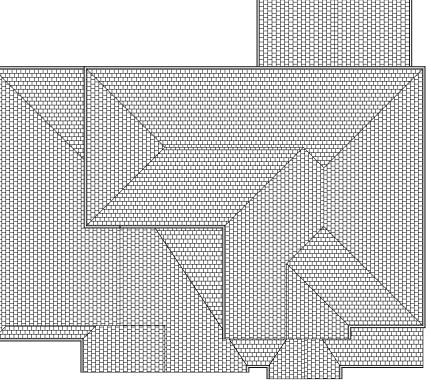
Lower Level - 1197 SF

TOTAL LIVING AREA - 3798 SF

Attached Garage - 1217 SF

Covered Front Deck - 175 SF/Covered Rear Deck - 240 SF

Eave = 16" Overhangs Gable = 16" Overhangs



Roof Layout

Not To Scale



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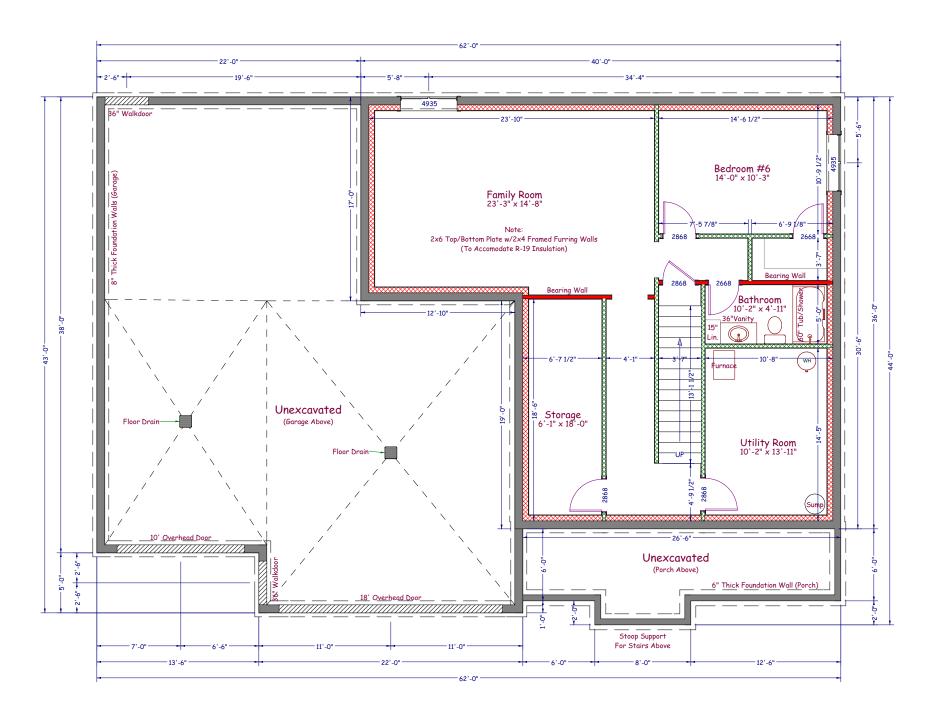
The "Bison" Two Story
Plans Drawn For:
Venture Building Company

 The plans and elevations are only conceptual and give the client an example of what is to be built. A contractor or an Architect is responsible for verifying the dimensions and other information on these plans. Inline designs cannot be held responsible for inaccurate information that may lead to additional cost for the owner or a delay in the project.

Basement:

All Exterior Foundation Walls Dimensioned From Outside of Foundation Wall To Outside Of Foundation Wall. All Interior Dimensions Are From The Inside Edge Of The Concrete Foundation Wall To Edge of Interior Wall Framing Or From Edge Of Framing To Edge Of Framing. Door Labels Are Specified By 3068 Which Translates To 3'-0" x 6'-8". Window Labels Are Specified By 2040 Which Translates To 2'-0" x 4'-0". Interior Bearing Walls Are Represented By Solid Walls





Foundation Plan

Scale: 1/8"=1'-0"

*2x6 Exterior House Walls - 9'-1 1/8" High *2x6 Exterior Garage Walls - 11'-2 1/4" High (Verify) *8" Thick Concrete Basement Walls - 92 7/8" Ceiling *20" Engineered Floor Trusses (Figured For Elevations) Actual Truss Size May Differ (Verify w/Truss Company)

Square Foot Calculations: Main Floor - 1197 SF

Second Floor - 1404 SF Lower Level - 1197 SF

TOTAL LIVING AREA - 3798 SF

Attached Garage - 1217 SF

Covered Front Deck - 175 SF/Covered Rear Deck - 240 SF





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The "Bison" Two Story Plans Drawn For: Venture Building Company

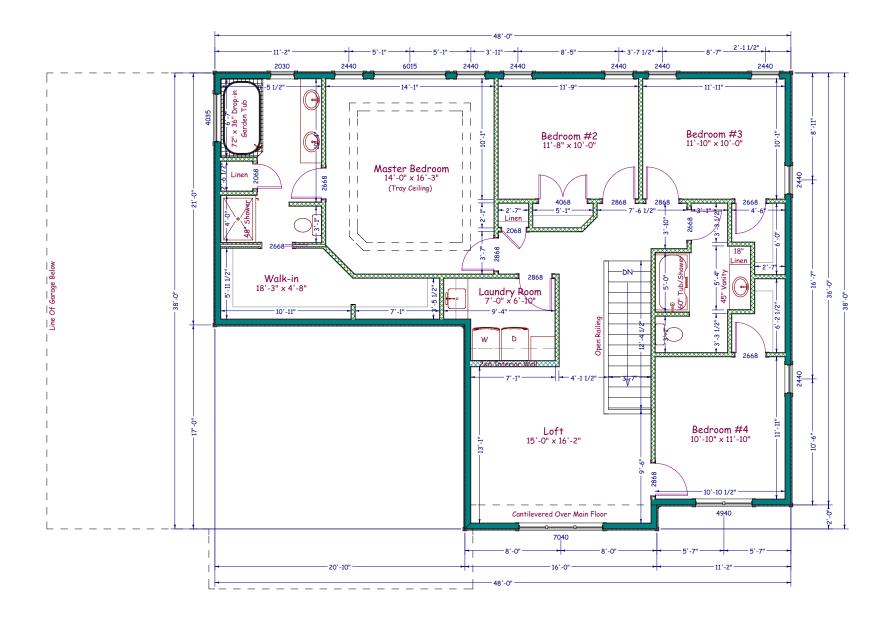
Drawn By: SRW Date:

4/17/2015

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Second Floor:

All Exterior Dimensions Are From Outside Of Framing To Outside Of Framing. All Interior Dimensions Are From Edge Of Framing To Edge Of Framing. Door Labels Are Specified By 3068 Which Translates To $3'-0" \times 6'-8"$. Window Labels Are Specified By 2040 Which Translates To $2'-0" \times 4'-0"$.



Second Floor Plan

Scale: 1/8"=1'-0"

*2x6 Exterior House Walls - 9'-1 1/8" High *2x6 Exterior Garage Walls - 11'-2 1/4" High (Verify)

*8" Thick Concrete Basement Walls - 92 7/8" Ceiling

*20" Engineered Floor Trusses (Figured For Elevations)
Actual Truss Size May Differ (Verify w/Truss Company)

Square Foot Calculations:

Main Floor - 1197 SF Second Floor - 1404 SF Lower Level - 1197 SF

TOTAL LIVING AREA - 3798 SF

Attached Garage - 1217 SF

Covered Front Deck - 175 SF/Covered Rear Deck - 240 SF





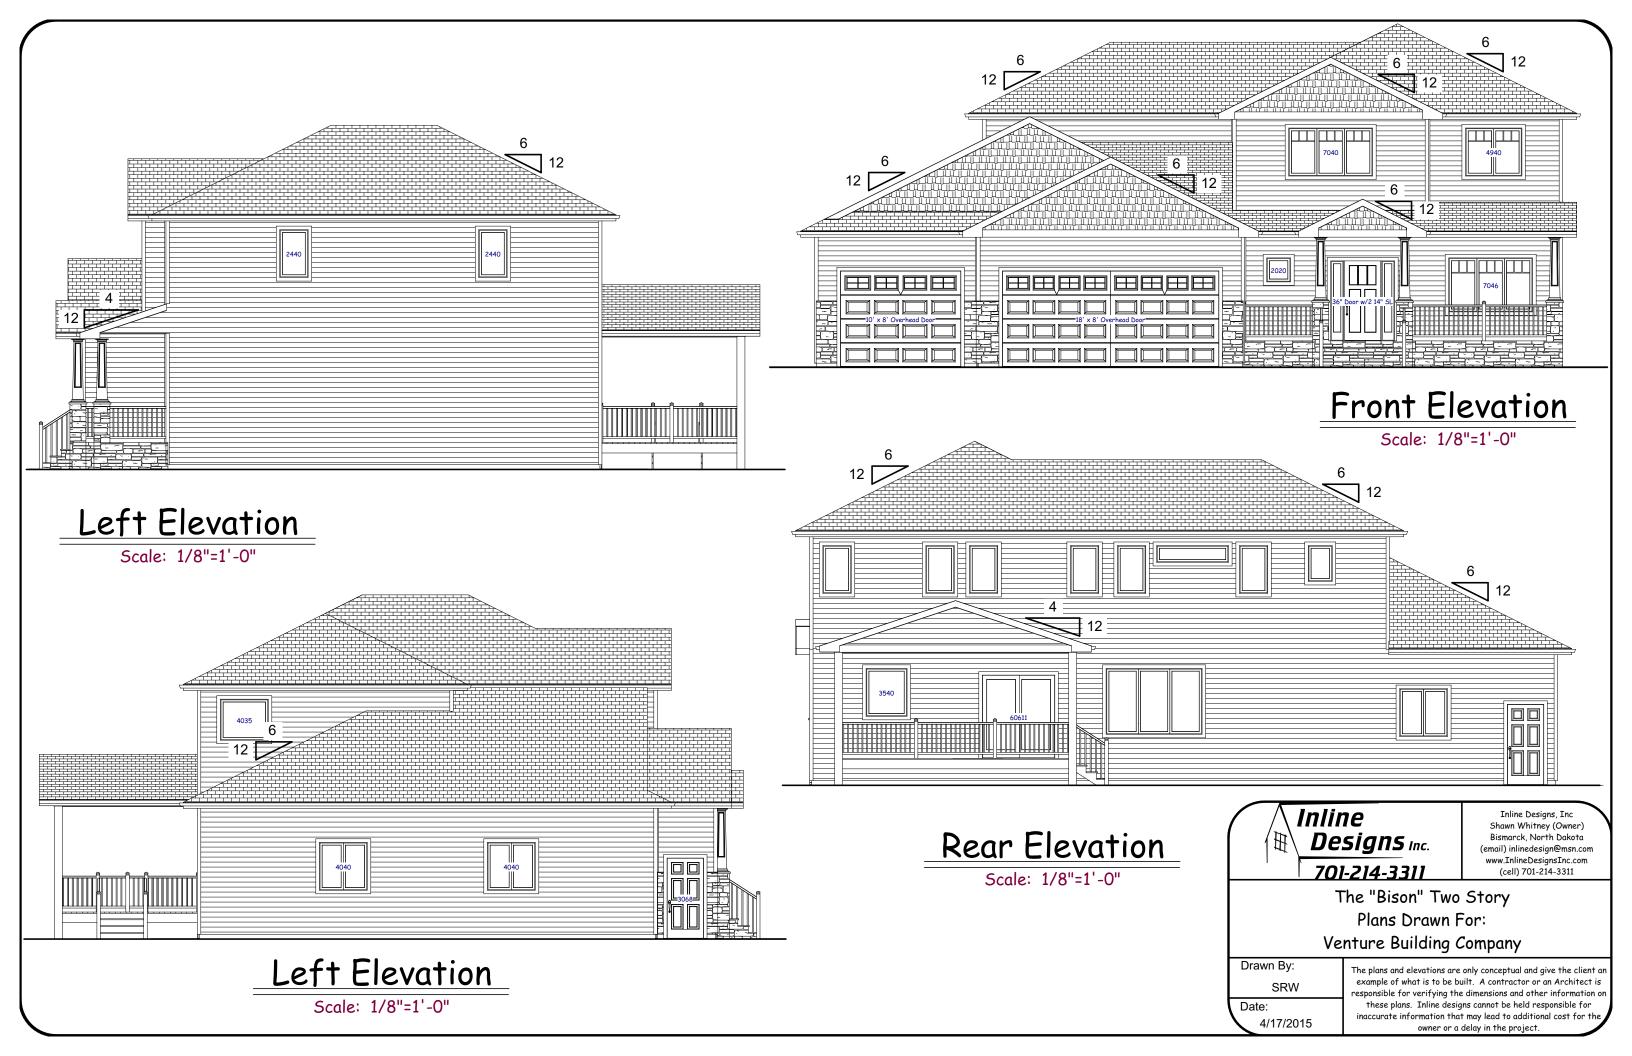
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The "Bison" Two Story
Plans Drawn For:
Venture Building Company

Drawn By: SRW Date: 4/17/2015

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